

BC Housing

OK Falls Senior Housing

5080 Highway 97 Okanagan Falls, BC, Canada

Issued for Temporary Use Permit Mar.22.18

PROJECT NO. 2016-043





500-1500 West Georgia Street Vancouver, BC V6G 2Z6 TEL 604-687-1898 FAX 604-682-5398

ARCHITECTURAL DRAWING LIST

CIVIL DRAWING LIST

LANDSCAPE DRAWING LIST

STRUCTURAL DRAWING LIST

MECHANICAL DRAWING LIST

ELECTRICAL DRAWING LIST

TECHNOLOGY DRAWING LIST

A_ARCH A-001 A-002 ASK-001 ASK-002 ASK-003 ASK-005 A-100 A-101 A-102 A-103 A-104 A-201 A-201 A-303 A-304 SYMBOLS, & GENERAL NOTES
ASSEMBLY SCHEDULES
FORM AND CHARACTER 3D
SITE PLAN
FIRST FLOOR PLAN
SECOND FLOOR PLAN
THIRD FLOOR PLAN
ROOF PLAN
EXTERIOR ELEVATIONS
EXTERIOR ELEVATIONS
EXTERIOR ELEVATIONS
SECTIONS - OVERALL BUILDING







CONSULTANTS:

IMPERIAL ALL DIMENSIONS UNLES NOTED ARE IN INCHES

NO. DATE
1 Mar.20.18 Issued for pre-DP App Review
2 Mar.22.18 Issued for Temporary Use Permit

OK Falls Senior Housing



DRAWING TITLE

FORM AND CHARACTER 3D

CHECKED BY: RC

DRAWN BY: RC

DATE: 03/22/18

SCALE: PROJECT NO.





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DRAWING TITLE

FORM AND CHARACTER 3D

CHECKED BY: RC

SCALE:

PROJECT NO.

2016-043 ASK-003

DRAWN BY: RC

DATE: 03/22/18







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SEALS:

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FORM AND CHARACTER 3D

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SITE PLAN GENERAL NOTES:

1. ARCHITECTURAL SITE PLAN TO BE READ IN CONJUNCTION WITH CIVIL, STRUCTURAL, MECHANICAL

ELECTRICAL, AND LANDSCAPE DRAWINGS. 2. ARCHITECTURAL SITE PLAN TO BE READ IN CONJUNCTION WITH THE BUILDING CODE REPORT, <u>Applicable</u>

<u>Building Code here</u> AND <u>Applicable Zoning Bylaw(s) here.</u>
3. REFER TO CIVIL DRAWINGS FOR PROPERTY SURVEY, FINAL GRADE ELEVATIONS AND PROPERTY LINE

4. REFER TO LANDSCAPE DRAWINGS FOR EXISTING TREES & PLANTING TO REMAIN.

FIRE & LIFE SAFETY GENERAL NOTES:

1. THIS PROJECT TO BE IN COMPLIANCE WITH ALL APPLICABLE FIRE AND LIFE SAFETY PROVISIONS AND REQUIREMENTS OF THE <u>BRITISH COLUMBIA BUILDING CODE 2012.</u> 2. REFER TO BUILDING CODE REPORT FOR SUMMARY OF PROGRAM OCCUPANT LOADS AND REQUIRED

EXIT CAPACITY, SPATIAL SEPARATION/UNPROTECTED OPENING EVALUATIONS AND PROPOSED ALTERNATIVE SOLUTIONS (IF ANY).

INTERIOR PARTITION GENERAL NOTES:

I. ALL INTERIOR DIMENSIONS IN THE DRAWINGS ARE MEASURED FROM GRIDLINES TO FACE OF FINISHED PARTITION UNLESS NOTED OTHERWISE. 2. REFER TO ROOM FINISH SCHEDULE, INTERIOR DRAWINGS AND SPECIFICATIONS FOR INTERIOR FINISHES

AND COLOUR SELECTIONS.

3. SEAL PERIMETER AND ALL PENETRATIONS THROUGH ALL FIRE RATED PARTITIONS WITH FIRE-RATED SEALANT, ALL SERVICE PENETRATIONS TO BE FIRE STOPPED WITH ACCEPTABLE ULC-APPROVED

-IRESTOP SYSTEMS. 1. ALL CLOSURES IN FIRE RATED PARTITIONS TO HAVE ULC-APPROVED LABELLED DOORS AND FRAMES. 1. ALL DUSONES IN THE RAYLO FRETATIONS OF UNION THE PASSAGE OF THE SEPARATIONS (SMOKE WALLS) WITH SMOKE-RATED SEALANT TO PREVENT HE PASSAGE OF SMOKE.

(6. SEAL PERMETER AND ALL PREVENTATIONS THROUGH ALL PARTITIONS WITH \$15 45 OR GREATER WITH

ISTIC NON-HARDENING SEALANT ALL ACQUISTIC PARTITIONS SHALL HAVE CONTINUOUS firm THICK

ACOUSTIC MON-HARDENING SEALANT, ALL ACOUSTIC PARTITIONS SHALL HAVE CONTINUOUS SHIRT INCK. FOAM TAPE AT TOP AND BOTTOM OF TRACK. 7. CONSTRUCT PARTITIONS IN COMPLIANCE WITH THE <u>BRITISH COLUMBIA BUILDING CODE (BCBC) 2012.</u> 8. ALL CYPSUIN BOADT TO BE 15mm (SBO) THICK TYPE X' UNLESS NOTEO OTHERWISE. 9. ALL PARTITIONS IN WASHROOMS, HOUSEKEEPING ROOMS, JANITOR SINKS AND HAND SINKS SHALL HAVE.

9. ALL PARTITIONS IN WASHROOMS, HOUSEKEEPING ROOMS, JANITOR SINKS AND HAND SINKS SHALL HAW WATER A BUD DESISTANT OF YEAU BOARD.

10. ALL TILE PARTITIONS IN SHOWER STALLS SHALL HAVE WATER RESISTANT TILE BACKERBOARD.

11. ALL STEEL STUDS TO BE 25 GAUGE UNLESS NOTED OTHERWISE.

12. CONTRACTOR TO CONFIRM ALL INTERIOR STUD SIZES SHOWN IN THE DRAWINGS INCLUDING BUT NOT LIMITED TO SPACING, GAUGE AND ATTACHMENT INCTHOP PER THE REQUIREMENTS OF THE <u>BCBC 2012</u>.

13. PROVIDE 2' (Somm) AIR SPACE BETWEEN FACE OF CONCRETE FOUNDATION WALLS, CONCRETE SHEAR WALLS, CONCRETE WALLS AND CONCRETE UNLINES TO ALLOW FOR UNEVER CONCRETE UNLESS NOTED OTHERWISE. HEIGHT OF STEEL FURRING AT CONCRETE WALLS AND CONCRETE OLUMINS TO ALLOW FOR UNEVER CONCRETE UNLESS NOTED OTHERWISE.

OTHERWISE.

14. REFERENCES TO BUILDING CODE FOR FIRE RATED PARTITIONS ARE PROVIDED TO GIVE AN INDICATION OF SOUND TRANSMISSION CLASS (STC) RATING ONLY, REFER TO ULC DESIGN NUMBER PROVIDED FOR FIRE RATING REQUIREMENTS.

15. TOP OF PARTIAL HEIGHT PARTITIONS TO BE TAPED, SANDED AND PAINTED TO MATCH VERTICAL FACE.

OF PARTITION UNLESS NOTED OTHERWISE.
16, EXTEND STUDS IN ALL INTERIOR PARTITIONS VERTICALLY FROM FLOOR TO UNDERSIDE OF STRUCTURE

ABOVE UNLESS NOTED OTHERWISE, EXTEND GYPSUM BOARD A MINIMUM OF 6" (150mm) ABOVE FINISHED CEILING IN NON-FIRE RATED & NON-ACOUSTICALLY RATED PARTITIONS.

7, ALL INTERIOR CONCRETE MASONRY UNIT (CMU) PARTITIONS SHALL HAVE BULL-NOSED RADIUS ON ALI XPOSED CORNERS AND DOOR JAMBS. 18. ALL DOOR FRAMES TO BE LOCATED 4" (100mm) AWAY FROM NEAREST ADJACENT PERPENDICULAR

ARTITION UNLESS NOTED OTHERWISE. 19. PROVIDE CONTINUOUS BACKER ASSEMBLIES BETWEEN STUDS AT LOCATIONS INCLUDING BUT NOT

IMITED TO HANDRAILS, BUMPER RAILS, WALL MOUNTED MILLWORK, ETC. REFER TO PLANS AND INTERIOR FLEVATIONS FOR EXTENT AND LOCATIONS. 20 AT FIRE RATED AND ACOUSTIC PARTITIONS. RECESSED ELECTRICAL AND DATA OUTLET BOXES THAT PENETRATE OPPOSITE SIDES OF A PARTITION TO BE SEPARATED BY A MINIMUM OF ONE STUD CAVITY

21. ALL CONCRETE MASONRY UNIT (CMU) PARTITIONS TO EXTEND TO UNDERSIDE OF STRUCTURE ABOVE PROVIDE CONTINUOUS COMPRESSIBLE JOINT FILLER AND SEALANT AT TOP OF ALL CMU PARTITIONS ROVIDE FIRESTOPPING AND SMOKE SEALS AT PERIMETER JOINTS AND PENETRATIONS IN FIRE RATED

PROVIDE LATERAL BRACING AT TOP OF CMU WALLS AND PARTITIONS PER THE REQUIREMENTS OF THE

<u>BCBC 2012.</u> 24. PROVIDE REINFORCEMENT OF CMU WALLS AND PARTITIONS PER THE REQUIREMENTS OF THE <u>BCBC</u>

2012.
25. REFER TO FIRE AND LIFE SAFETY PLANS FOR LOCATION OF REQUIRED FIRE SEPARATIONS.
26. AT RECESSED PANEL LOCATIONS (EG. ELECTRICAL PANELS) WITHIN FIRE RATED PARTITIONS, PROVIDE CONTINUITY OF THE REQUIRED RATING BEHIND AND AROUND THE PANEL.
27. PROVIDE CONTROL JOINT'S IN CYPSUM BOARD ASSEMBLES AS FOLLOWS OR UNLESS NOTED

INTERIOR PARTITIONS - 9m (30') MAX. SPACING IN EITHER DIRECTION

INTERIOR CEIUNS - 15m (10.7) IMAX. SPACING IN ETHER DIRECTION (WITH PERIMETER RELIEF); 9m (20) MAX. SPACING IN ETHER DIRECTION (WITHOUT PERIMETER RELIEF) CONTRACTOR TO CONFIRM LOCATIONS WITH ARCHITECT PRIOR TO INSTALLATION. AT CONTROL JOINTS LOCATED IN FIRE RATED PARTITIONS, PROVIDE APPROVED FIRE TESTED ASSEMBLY WITHIN DESTRICT. WITHIN PARTITION.

WITHIN PARTITION. 28. REFER TO INTERIOR ELEVATIONS FOR LOCATION OF DECORATIVE REVEALS. PROVIDE DOUBLE LAYER OF GYPSUM BOARD IF REVEAL IS LOCATED WITHIN A FIRE RATED PARTITION. 28 FIRE RATED HORIZONTAL SHAFT WALL ASSEMBLIES TO BE CONSTRUCTED AND INSTALLED PER OBMEC

AUTHORIZATION #89-1-118 OR UNI ESS NOTED OTHERWISE. 29 CONTRACTOR TO PROVIDE ASSEMBLY AT TOP OF INTERIOR PARTITIONS (SLOTTED TOP TRACK IN

STEEL STUD ASSEMBLIES) TO ALLOW FOR VERTICAL DEFLECTION OF STRUCTURE ABOVE.

30. ALL COMMUNICATIONS & ELECTRICAL ROOMS TO HAVE FIRE-TREATED PLYWOOD ON INSIDE OF THE ROOM FROM BASE OF WALL TO 7:0" ABOVE FINISHED FLOOR FOR THE MOUNTING OF COMMUNICATIONS &

ELECTRICAL PANELS.

31. ALL INTERIOR PARTITIONS TO BY TYPE P1 U.N.O.

INTERIOR FINISH PLAN GENERAL NOTES:

1. REFER TO SPECIFICATIONS FOR SPECIFIC MATERIAL AND/OR PRODUCT SELECTIONS.

INSTALL ALL FINISHES AS PER MANUFACTURES RECOMMENDATIONS.
 ALL PATTERNS SHOWN ON THE FLOOR FINISH PLANS ARE PROVIDED TO INDICATE EXTENT OF FLOORING

ONLY, REFER TO OTHER PLANS FOR SPECIFIC FLOOR PATTERN LAYOUTS.

4. ALL PARTITIONS AND GYPSUM BOARD CEILINGS TO BE PAINT COLOUR "22" UNLESS OTHERWISE NOTED 5. ALL FINISHES TO FOLLOW PROJECT AGREEMENT REQUIREMENT, NOTIFY DESIGNER IMMEDIATELY

CREPANCIES ARE FOUND.

6. FLOOR BASE TO BE 100mm UNLESS OTHERWISE NOTED

REFER TO DWG AX XX FOR WALL PROTECTION TYPES & DETAILS.

8. ALL INTERIOR STEEL WINDOW AND DOOR FRAMES TO BE PAINT COLOUR "XX" UNLESS OTHERWISE

MILLWORK GENERAL NOTES:

1 ALL MILLWORK TO MEET THE STANDARDS AND REQUIREMENTS OF THE ARCHITECTURAL WOODWORK

IANUFACTURERS ASSOCIATION OF CANADA (AWMAC). , CONTRACTOR TO CONFIRM LOCATIONS OF UPPER AND LOWER CABINETS AND REPORT ANY CONFLICTS BETWEEN THE ARCHITECTURAL DRAWINGS AND THAT OF ANY OTHER CONSULTANT'S DRAWINGS TO THE

RCHITECT. . CONTRACTOR TO COORDINATE AND SEQUENCE INSTALLATION OF MECHANICAL AND ELECTRICAL WORK

3. CONTRACTOR TO COORDINATE AND SEQUENCE INSTALLATION OF MECHANICAL AND ELECTRICAL WORK WITH ALL MILLWORK AS REQUIRED.

4. CONTRACTOR TO COORDINATE EXTENT OF FLOORING WITH ALL MILLWORK.

5. REFER TO SPECIFICATION FOR INFORMATION REGARDING FINISHES, CABINET HARDWARE, MATERIAL SUPPLY, DELIVERY, FABRICATION AND INSTALLATION OF MILLWORK.

6. ALL UPPER CABINETS TO HAVE FILLER PANEL UNLESS NOTEO OTHERWISE.

7. ALL INSTALLATIONS TO HAVE AN END GABLE WHERE UPPER AND/OR LOWER CABINETS AND SHELVES DO NOT TERMINATE AGAINST A SIDE WALL.

8. ALL LOWER CABINETS TO BE 610mm (24") DEEP UNLESS NOTED OTHERWISE. REFER TO MILLWORK DIFTALLS.

9. ALL UPPER CABINETS TO BE 330mm (13") DEEP UNLESS NOTED OTHERWISE. REFER TO MILLWORK

10. ALL FULL HEIGHT CABINETS TO BE 610mm (24") DEEP UNLESS NOTED OTHERWISE. REFER TO MILLWORK

11. INSTALL BLANK FILLER PANELS AS REQUIRED TO COMPLETE FULL LENGTH DIMENSION, WHERE FILLER PANELS ARE NOTED ON INTERIOR ELEVATIONS. FILLER PANEL ARE TO BE INSTALLED ON ALL EXPOSED SIDES UNLESS NOTED OTHERWISE.

12. PROVIDE CONTINUOUS BACKER ASSEMBLIES BETWEEN STUDS AT LOCATIONS INCLUDING BUT NOT LIMITED TO HANDRAILS BUMPER RAILS WALL MOUNTED MILL WORK ETC. REFER TO PLANS AND INTERIOR FLEVATIONS FOR EXTENT AND LOCATIONS

13 INSTALL SUPPORT STEEL BRACKETS FOR LONG SPANS AT OPEN COUNTERS

14. ALL BOTTOMS OF SINK CABINET BOXES TO HAVE MARINE-GRADE PLYWOOD SUBSTRATE.
15. MARINE-GRADE PLYWOOD SUBSTRATE TO BE USED FOR COUNTERTOPS. NO FIBREBOARD OR PARTICLEBOARD ALLOWED.

IS SEAL ALL MOOD SURFACES AND EDGES. ALL DOOR, DRAWER AND OTHER EXPOSED MILLWORK EDGES. TO HAVE APPLIED APPROPRIATELY SIZED PVC EDGE STRIP, HEAT APPLIED TO MATCH P-LAM COLOUR. NO P-LAM TO P-LAM EDGES ARE ALLOWED.

17. STAINLESS STEEL CASEWORK:

(a) TO BE FABRICATED FROM TYPE 304, NO 4 FINISH STAINLESS STEEL.
(b) CORNERS TO BE WELDED, GROUND, POLISHED AND CREVICE-FREE. JOINTS AND WELDS WILL BE POLISHED TO A UNIFORM NO 4 SATIN FINISH. NO FILLER OR SOLDERS TO BE USED. STRAIGHT LENGTHS TO BE OWNED FROM NO 4 SATIN FINISH. NO FILLER OR SOLDERS TO BE USED. STRAIGHT LENGTHS TO BE OWNED FROM NO 15 SAND INCOME. SHAPPING TO BE OWNED FROM THE WATER PROOF OWNED FROM STAINLES AND STRAIGHT LENGTHS WITH WATER PROOF CONTACT CEMENT. SEAL UNDERSIDE OF TOP (PLYWOOD CORE) WITH A WATER PROOF FINISH. THE FRONT EDGES OF THE TOPS WILL BE MARINE EDGE. FORM BACKSPLASH AS AN INTEGRAL PART OF THE TOPS, RADIUSED WHERE THE BACKSPLASH AS SPECIFIED FOR THE TOPS. BOND ALL BACKSPLASH OF THE TOPS. ADDIVISION WHERE THE BACKSPLASH OF ONE PICE OF STAIN FESS STEFT, WIT D.

COUNTERTOPS, BACKSPLASHES, AND FRONT APRONS OUT OF ONE PIECE OF STAINLESS STEEL. WELD COUNTER AND SINK ASSEMBLIES INTO SINGLE UNITS WITHOUT SEAMS OR JOINTS. DRILL BACKSPLASHES, TOPS AND SINKS TO RECEIVE PLUMBING AND ELECTRICAL FITTINGS. ALL COUNTERTOPS TO HAVE

MATTINE EDGE. (d) FORM INTEGRAL SINKS WITH ALL WELDED ROUNDED CORNERS, SEAMLESS CONSTRUCTION WITH ALL TRACES OF WELDING REMOVED. WELD STAINLESS STEEL SINKS INTEGRALLY INTO TOPS WITHOUT SEAMS OR JOINTS. SLOPE TOPS FOR SINKS AND ADJACENT DRAIN BOARDS TO SINKS. ALL COUNTERTOPS WITH SINKS TO HAVE MARINE EDGE.

REFLECTED CEILING PLAN GENERAL NOTES:


 ALL CEILING HEIGHTS TO BE AT XXXXXmm ABOVE FINISHED FLOOR UNLESS NOTED OTHERWISE.
 REFLECTED CEILING PLANS TO BE READ IN CONJUNCTION WITH ROOM FINISH SCHEDULES,
 SPECIFICATIONS, ARCHITECTURAL CEILING DETAILS, STRUCTURAL, MECHANICAL, ELECTRICAL, FIRE ROTECTION AND FIRE & LIFE SAFETY DRAWINGS.

B. THE MECHANICAL AND ELECTRICAL DRAWINGS SHALL GOVERN OVER THE ARCHITECTURAL DRAWINGS

FOR DEVICE TYPE AND QUANTITY. THE ARCHITECTURAL DRAWINGS SHALL GOVERN OVER THE MECHANICAL AND ELECTRICAL DRAWINGS FOR LOCATION.
4. CONTRACTOR TO REPORT ANY DISCREPANCIES ANDOR INCONSISTENCIES BETWEEN THE ARCHITECTURAL DRAWINGS AND THAT OF ANY OTHER CONSULTANT'S DRAWINGS TO THE ARCHITECT.

5. CONTRACTOR TO BENEW AND COORDINATE THE LOCATION OF ACCESS PANELS WITH MECHANICAL AND ELECTRICAL DRAWINGS. FINAL COCTIONS OF ACCESS PANELS TO BE REVIEWED BY MEP CONSULTANT AND ARCHITECT PRIOR TO INSTALLATION, ACCESS PANELS TO MATCH CEILING FINISH COLOUR. 6. IN ACQUISTIC TILE CEILINGS. FIXTURES GRAPHICALLY SHOWN IN THE DRAWINGS AS INTERSECTING T-BAR SUSPENSION SYSTEMS AND/OR OTHER ELEMENTS ARE TO BE LOCATED WITHIN THE NEAREST

. THE STANDARD PLACEMENT OF CEILING MOUNTED DEVICES WITHIN A SINGLE FULL SIZED (610mm X mm) ACOUSTIC CEILING TILE SHALL BE THE FOLLOWING UNLESS NOTED OTHERWIS

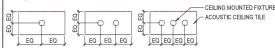

8. MOUNT ALL FIXTURES IN EXPOSED CEILINGS AT $\underline{\textit{XXXXmm}}$ ABOVE FINISHED FLOOR UNLESS NOTED OTHERWISE.

DOOR SCHEDULE GENERAL NOTES:

VALUABLE CELLING THE

. DOOR SCHEDULE TO BE READ IN CONJUNCTION WITH THE BUILDING CODE REPORT.

ALL DOORS IN FIRE SEPARATIONS TO CONTAIN APPROPRIATE ULC LISTED SELF-CLOSING DEVICES AND
POSITIVE LATCHING HARDWARE.). ALL DOORS IN FIRE SEPARATIONS TO CONTAIN APPROPRIATE DECLIFIED SELF-CEDSING DEVICE. B. ALL DOORS IN FIRE SEPARATIONS TO CONTAIN APPROPRIATE ULC LISTED DOORS, FRAMES AND

HARDWARE.

4. THE MAXIMUM TEMPERATURE RISE ON THE OPAQUE PORTION OF THE UNEXPOSED SIDE OF A DOOR USED AS A CLOSURE IN A FIRE SEPARATION SHALL CONFORM TO THE <u>Applicable Buildina Code here</u>.

5. REFER TO HARDWARE SPECIFICATION FOR REQUIRED DOOR AND FRAME HARDWARE.

6. ALL GLAZING IN FIRE RATED DOORS, SIDELITES AND LOCATIONS WHERE IMPACT SAFETY IS REQUIRED SHALL BE FIRE RATED SAFETY GLASS TO MEET MINIMUM CLASS B RATING STANDARD PER THE REQUIREMENTS OF THE CANADIAN GENERAL STANDARDS DEAD (CGSB).

7. PROVIDE WEATHER STRIPPING FOR ALL EXTERIOR DOORS UNLESS NOTED OTHERWISE.

8. PROVIDE MINIMUM 6mm (147) DOOR UNDERCOUT AT ALL INTERIOR DOORS UNLESS NOTED OTHERWISE.

9. REFER TO THE ELECTRICAL DRAWINGS FOR LOCATION OF DOORS WITH POWER REQUIREMENTS.

INTERIOR ELEVATION GENERAL NOTES:

I. PROVIDE CONTINUOUS BACKER ASSEMBLES BETWEEN STUDS AT LOCATIONS INCLUDING BUT NOT LIMITED TO HANDRAILS, BUMPER RAILS, WALL MOUNTED MILLWORK, ETC.

2. INTERIOR ELEVATIONS ARE TO BE READ IN CONJUNCTION WITH THE FIRE A LIFE SAFETY PLANS, EQUIPMENT PLANS, FINISH PLANS, TYPICAL MOUNTING HEIGHT DETAILS, REFLECTED CEILING PLANS, INTERIOR DETAILS, MECHANICAL AND ELECTRICAL DRAWINGS.


3. REFERT DI TYPICAL MOUNTING HEIGHT DRAWINGS FOR VERTICAL MOUNTING HEIGHT DIMENSIONS.

4. REFER TO ROOM FINISH SCHEDULE FOR WALL FINISH INFORMATION.

5. MILLWORK FILLER PANELS TO BE FINISHED TO MATCH THE FINISH OF ADJACENT WALL COLOUR.

7. FINISH OF MILLWORK FILLER PANELS BETWEEN CABINETS AND WALLS AND CABINETS AND CEILINGS IS TO MATCH FINISH OF MILLWORK THEY ARE INSTALLED AGAINST. TYP, UNLESS NOTED OTHERWISE.

ARCHITECTURAL SYMBOLS

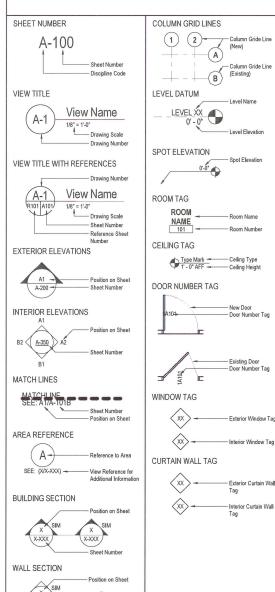

(X-XXX) **DETAIL - SECTION**

X-XXX

DETAIL - PLAN/RCP

(X-XXX)

DRAWING REVISIONS


NORTH ARROW

GRAPHIC SCALE

Plan North

SIM

SIM

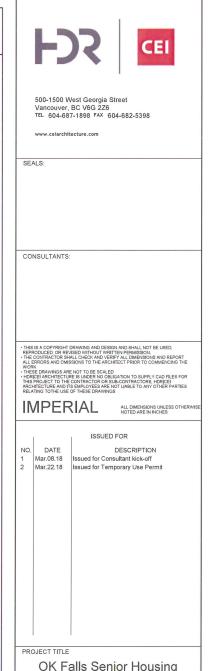

BC HOUSING

SYMBOLS, & GENERAL

NOTES

DRAWN BY: DS

DATE: 03/22/18

A-00[°]


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SCALE: 12" = 1'-0"


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INTER	INTERIOR PARTITION ASSEMBLIES			FIRE RESISTANCE RATING
(C8)		REINFORCED CONCRETE WALL - REINFORCED CONCRETE THICKNESS AND REINFORCING AS PER STRUCTURAL NOTE; NO CHAMFERS ON ALL EXPOSED CONCRETE		
(PW1)	<u></u>	TYPICAL INTERIOR PARTYWALL PARTITION - SHEAR - 5/6" TYPE-X GYPSUM WALL BOARD - 5/6" PLYWOOD SHEATHING - REFER TO STRUCTURAL - 2x4 WOOD STUDS @ 16°o.c. OR AS PER STRUCTURAL - 1" AR SPACE - 50UND ATTENUATION BATTS INSULATION (FILL STUD CAVITY) - 2x4 WOOD STUDS @ 16°o.c. OR AS PER STRUCTURAL - 2-LAYERS 5/6" TYPE-X GYPSUM WALL BOARD	61 BCBC W14a	1hr* *PRESCRIPTIVE BCBC 2012 APPENDIX D
(PW2)		TYPICAL INTERIOR PARTYWALL (CORRIDOR) PARTITION - 2-LAYER 5/8" TYPE-X GYPSUM WALL BOARD - 1/2" RESULENT METAL CHANNEL (B. 2"4" oc. (HORIZ.) - STAGGERED 2/4 WOOD STUDIO (B. 16" oc. ON COMMON 2:6 PLATE - SOUND ATTENUATION BATTS INSULATION (FILL STUD CAVITY) - 5/8" TYPE-X GYPSUM WALL BOARD	56 BCBC W11a	1hr* *PRESCRIPTIVE BCBC 2012 APPENDIX D
P1		TYPICAL INTERIOR PARTITION - 56" TYPE-X GYPSUM WALL BOARD - 24 WOOD STUDS @ 16"oc. OR AS PER STRUCTURAL - 56" TYPE-X GYPSUM WALL BOARD		
(P2)*		TYPICAL INTERIOR PARTITION - 56° TYPE-X GYPSUM WALL BOARD - 266 WOOD STUDS @ 16° oc. OR AS PER STRUCTURAL - 56° TYPE-X GYPSUM WALL BOARD 'REMOVE 1 LAYER GWB TO CREATE PLUMBING FURRING WALL		
(sw1)		TYPICAL SHAFT WALL - 5/8" TYPE-X GYPSUM WALL BOARD - 2 1/2" C-T METAL STUDS - 1" GYPSUM SHAFTLINER		1hr ULC DESIGN No. W446 Syestem F
(SW1a)	7	TYPICAL SHAFT WALL W PLY BACKING -5/6" TYPE-X GYPSUM WALL BOARD -1/2" PLYWOOD SHEATHING -2 1/2" C-1 WEAL STUDS		1hr ULC DESIGN No. W446 Syestem F

ROOF ASSEMBLIES TYPICAL INSULATED TPO ROOF - FULLY ADHERED TPO ROOFING MEMBRANE - 1" (min.) EPS RIGID INSULATION - SLOPED TO DRAIN (min 2%) 5/8" T&G SHEATHING R1 11 7/8" TJI ROOF JOISTS - REFER TO STRUCTURAL R40 BATT INSULATION (FILL VOID) 6 MIL POLY VAPOUR BARRIER 5/8" TYPE-X GYPSUM BOARD TYPICAL UNINSULATED CANOPY ROOF - FULLY ADHERED TPO ROOFING MEMBRANE - 1" (min.) EPS RIGID INSULATION - SLOPED TO DRAIN (min 2%) - 5/8" TAG SHEATHING - 11 17/8" T.II ROOF JOISTS - REFER TO STRUCTURAL - PREFINISHED 1x4 T&G FIR SOFFIT $\langle R2 \rangle$ TYPICAL INSULATED TPO ROOF -FULLY ADHERED TPO ROOFING MEMBRANE -1* (min), EPS RIGID INSULATION - SLOPED TO DRAIN (min 2%) -5/8* T&G SHEATHING -24* ENGINEERED ROOF JOISTS - REFER TO STRUCTURAL - R40 BATT INSULATION (R3) - 6 MIL POLY VAPOUR BARRIER - 5/8" TYPE-X GYPSUM BOARD



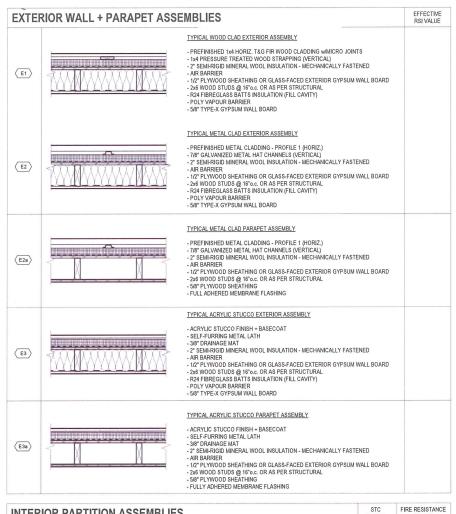

SOFFIT ASSEMBLIES							
(\$1)	\	TYPICAL WOOD SOFFIT - PREFINISHED 1x4 T&G FIR SOFFIT					

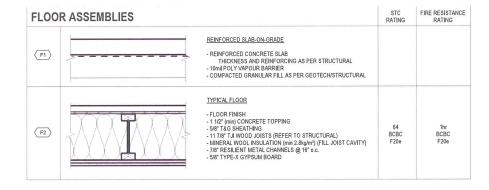INTERIOR PARTITION GENERAL NOTES:

, ALL INTERIOR DIMENSIONS IN THE DRAWINGS ARE MEASURED FROM GRIDLINES TO FACE OF FINISHED

PARTITION UNLESS NOTED OTHERWISE. P. REFER TO ROOM FINISH SCHEDULE, INTERIOR DRAWINGS AND SPECIFICATIONS FOR INTERIOR FINISHES ND COLOUR SELECTIONS.

AND COLOUR SELECTIONS. B. SEAL PERIMETER AND ALL PENETRATIONS THROUGH ALL FIRE RATED PARTITIONS WITH FIRE-RATED SEALANT, ALL SERVICE PENETRATIONS TO BE FIRE STOPPED WITH ACCEPTABLE ULC-APPROVED

TRESTOR STSTEMS. I ALL CLOSURES IN FIRE RATED PARTITIONS TO HAVE ULC-APPROVED LARFLLED DOORS AND FRAMES.

FINES 107-SYSTEMS IN FIRE RATED PARTITIONS TO HAVE U.C.APPROVED LABELLED DOORS AND FRAMES.

4. ALL CLOSURES IN FIRE RATED PARTITIONS THROUGH ALL 0-HOUR RATED FIRE SEPARATIONS (SMOKE WALLS) WITH SMOKE-RATED SEALANT TO PREVENT THE PASSAGE OF SMOKE.

6. SEAL PERMIETER AND ALL PENETRATIONS THROUGH ALL PARTITIONS WITH STC 45 OR GREATER WITH ACQUISTIC NON-HARDENING SEALANT. ALL ACOUSTIC PARTITIONS SHALL HAVE CONTINUOUS 6mm THICK FOAM TAPE AT TOP AND BOTTOM OF TRACK.

7. CONSTRUCT PARTITIONS IN COMPLIANCE WITH THE BRITISH COLUMBIA BUILDING CODE (BCBC) 2012.

8. ALL GYPSUM BOARD TO BE 16mm (S/B*) THICK "TYPE X" UNLESS NOTED OTHERWISE.

9. ALL PARTITIONS IN WASHROOMS, HOUSEKEEPING ROOMS, JANTOR SINKS AND HAND SINKS SHALL HAVE WATER A MOLD RESISTANT GYPSUM BOARD.

10. ALL TILE PARTITIONS IN SHOWER STALLS SHALL HAVE WATER RESISTANT TILE BACKERBOARD.

11. ALL STEEL STUDS TO BE 25 GAUGE UNLESS NOTED OTHERWISE.

12. CONTRACTOR TO CONFIRM ALL INTERIOR STUD SIZES SHOWN IN THE DRAWINGS INCLUDING BUT NOT LIMITED TO SPACING, GAUGE AND ATTACHMENT METHOD PER THE REQUIREMENTS OF THE BCBC 2012.

13. PROVIDE 2" (50mm) AIR SPACE BETWEEN FACE OF CONCRETE AND INSIDE FACE OF STEEL FURRING AT ALL LOCATIONS INCLUDING BUT NOT LIMITED TO SPACING, GAUGE AND ATTACHMENT METHOD PER THE REQUIREMENTS OF THE BCBC 2012.

13. PROVIDE 2" (50mm) AIR SPACE BETWEEN FACE OF CONCRETE AND INSIDE FACE OF STEEL FURRING AT ALL LOCATIONS INCLUDING BUT NOT LIMITED OT STEEL FURRING AT ALL LOCATIONS INCLUDING BUT NOT TO CONCRETE FOUNDATION WALLS, CONCRETE WALLS AND CONCRETE COLUMNS TO ALLOW FOR UNEVEN CONCRETE UNLESS NOTED OTHERWISE.

THERWISE. 14. REFERENCES TO BUILDING CODE FOR FIRE RATED PARTITIONS ARE PROVIDED TO GIVE AN INDICATION OF SOUND TRANSMISSION CLASS (STC) RATING ONLY. REPERT TO ULC DESIGN NUMBER PROVIDED FOR FIRE RATING REQUIREMENTS.

15. TOP OF PARTIAL HEIGHT PARTITIONS TO BE TAPED, SANDED AND PAINTED TO MATCH VERTICAL FACE

15, IDP OF PARTIAL HEIGHT PARTITIONS TO BE TAPED, SANDED AND PARTIAL MURES NOTED OTHERWISE.

16, EXTEND STUDS IN ALL INTERIOR PARTITIONS VERTICALLY FROM FLOOR TO UNDERSIDE OF STRUCTURE ABOVE UNLESS NOTED OTHERWISE. EXTEND GYPSUM BOARD A MINIMUM OF 6" (150mm) ABOVE FINISHED CEILING IN NON-FIRE RATED & NON-ACOUSTICALLY RATED PARTITIONS.

17. ALL INTERIOR CONCRETE MASONRY UNIT (CMU) PARTITIONS SHALL HAVE BULL-NOSED RADIUS ON ALL EXPOSED CORNERS AND DOOR JAMBS.

EXPOSED CORNERS AND DOOR JAMBS

18. ALL DOOR FRAMES TO BE LOCATED 4" (100mm) AWAY FROM NEAREST ADJACENT PERPENDICULAR PARTITION UNLESS NOTED OTHERWISE.

19. PROVIDE CONTINUOUS BACKER ASSEMBLIES BETWEEN STUDS AT LOCATIONS INCLUDING BUT NOT LIMITED TO HANDRAILS, BUMPER FAILS, WALL MOUNTED MILLWORK, ETC. REFER TO PLANS AND INTERIOR ELEVATIONS FOR EXTENT AND LOCATIONS.

20. AT FIRE RATED AND ACQUISITE PARTITIONS, RECESSED ELECTRICAL AND DATA OUTLET BOXES THAT PENEITRATE OPPOSITE SIDES OF A PARTITIONS TO EXTEND TO UNDERSIDE OF STRUCTURE ABOVE UNLESS NOTED OTHERWISE.

22. PROVIDE CONTINUOUS COMPRESSIBLE JOINT FILLER AND SEALANT AT TOP OF ALL CMU PARTITIONS, PROVIDE FIRESTOPPING AND SMOKE SEALS AT PERIMETER JOINTS AND PENETRATIONS IN FIRE RATED PARTITIONS A REQUIRED.

PARTITIONS AS REQUIRED.
23. PROVIDE LATERAL BRACING AT TOP OF CMU WALLS AND PARTITIONS PER THE REQUIREMENTS OF THE

<u>BCBC 2012.</u> 24. PROVIDE REINFORCEMENT OF CMU WALLS AND PARTITIONS PER THE REQUIREMENTS OF THE <u>BCBC</u>

<u>2012</u>. 25. REFER TO FIRE AND LIFE SAFETY PLANS FOR LOCATION OF REQUIRED FIRE SEPARATIONS.

28. AT RECESSED PANEL LOCATIONS (E.G. ELECTRICA) PANELS WITHIN FIRE FATED PARTITIONS, PROVIDE CONTINUITY OF THE REQUIRED RATING BEHIND AND AROUND THE PANEL. 27. PROVIDE CONTINUITY ON THE REQUIRED RATING BEHIND AND AROUND THE PANEL.

INTERIOR PARTITIONS - 9m (30') MAX, SPACING IN EITHER DIRECTION INTERIOR CEILINGS = 15m (15') MAX. SPACING IN EITHER DIRECTION (WITH PERIMETER RELIEF): 9m (30') MAX. SPACING IN FITHER DIRECTION (WITHOUT PERIMETER RELIEF) (30') MAX. SPACING IN EITHER DIRECTION (WITHOUT PERIMETER RELIEF) CONTRACTOR TO CONFIRM LOCATIONS WITH ARCHITECT PRIOR TO INSTALLATION. AT CONTROL JOINTS LOCATED IN FIRE RATED PARTITIONS, PROVIDE APPROVED FIRE TESTED ASSEMBLY WITHIN PARTITION

28 REFER TO INTERIOR ELEVATIONS FOR LOCATION OF DECORATIVE REVEALS. PROVIDE DOUBLE LAYER


28. REFER TO INTENIOR ELEVATIONS FOR LOCATION OF DECORATIVE REVEALS, PROVIDE DOUBLE LAYER OF GYPSUM BOARD IR REVEAL IS LOCATED WITHIN A FIRE RATED PARTITION.
28. FIRE RATED HORIZONTAL SHAFT WALL ASSEMBLES TO BE CONSTRUCTED AND INSTALLED PER OBMEC AUTHORIZATION #89-1-118 OR UNLESS NOTED OTHERWISE.
29. CONTRACTOR TO PROVIDE ASSEMBLY AT TOP OF INTERIOR PARTITIONS (SLOTTED TOP TRACK IN STEEL STUD ASSEMBLES) TO ALLOW FOR VERTICAL DEFLECTION OF STRUCTURE ABOVE.
30. ALL COMMONICATIONS & LECETRICAL POOR TO THAT PROVIDED TO THE ROOM FROM BASE OF WALL TO 7-0° ABOVE FINISHED FLOOR FOR THE MOUNTING OF COMMUNICATIONS & ELECTRICAL PANELS.
31. ALL INTERIOR PARTITIONS TO BY TYPE PLUNO.

REFLECTED CEILING PLAN GENERAL NOTES:

1. ALL CEILING HEIGHTS TO BE AT XXXXmm ABOVE FINISHED FLOOR UNLESS NOTED OTHERWISE. 2. REFLECTED CEILING PLANS TO BE READ IN CONJUNCTION WITH ROOM FINISH SCHEDULES, SPECIFICATIONS, ARCHITECTURAL CEILING DETAILS, STRUCTURAL, MECHANICAL, ELECTRICAL, FIRE TECTION AND FIRE & LIFE SAFETY DRAWINGS.

3 THE MECHANICAL AND ELECTRICAL DRAWINGS. FOR DEVICE TYPE AND QUANTITY. THE ARCHITECTURAL DRAWINGS SHALL GOVERN OVER THE MECHANICAL AND ELECTRICAL DRAWINGS FOR LOCATION

MECHANICAL AND ELECTRICAL DRAWINGS FOR LOCATION. 4. CONTRACTOR TO REPORT ANY DISCREPANCIES AND/OR INCONSISTENCIES BETWEEN THE ARCHITECTURAL DRAWINGS AND THAT OF ANY OTHER CONSULTANT'S DRAWINGS TO THE ARCHITECT. 5. CONTRACTOR TO REVIEW AND COORDINATE THE LOCATION OF ACCESS PANELS WITH MECHANICAL AND 5. CONTRACTOR TO REVIEW AND COORDINATE THE LOCATION OF ACCESS PANELS WITH MECHANICAL AN ELECTRICAL DAYWINGS. FINAL LOCATIONS OF ACCESS PANELS TO BE REVIEWED BY MEP CONSULTANT AND ARCHITECT PRIOR TO INSTALLATION. ACCESS PANELS TO MATCH CEILING FINISH COLOUR.
6. IN ACOUSTIC TILE CEILINGS, FIXTURES GRAPHICALLY SHOWN IN THE DRAWINGS AS INTERSECTING T-BAR SUSPENSION SYSTEMS AND/OR OTHER ELEMENTS ARE TO BE LOCATED WITHIN THE NEAREST AVAILABLE CEILING TILE.
7. THE STANDARD PLACEMENT OF CEILING MOUNTED DEVICES WITHIN A SINGLE FULL SIZED (610mm X 1220mm) ACOUSTIC CEILING TILE SHALL BE THE FOLLOWING UNLESS NOTED OTHERWISE.

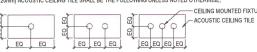

8. MOUNT ALL FIXTURES IN EXPOSED CEILINGS AT XXXXmm ABOVE FINISHED FLOOR UNLESS NOTED



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DATE DESCRIPTION Issued for Consultant kick-off Mar.08.18 Mar.20.18 Issued for pre-DP App Review
Mar.22.18 Issued for Temporary Use Permit

OK Falls Senior Housing



BC Housing

5080 Highway 97 Okanagan Falls, BC, Canada

DRAWING TITLE


ASSEMBLY SCHEDULES

SCALE: As indicated

2016-043

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DATE: 03/22/18




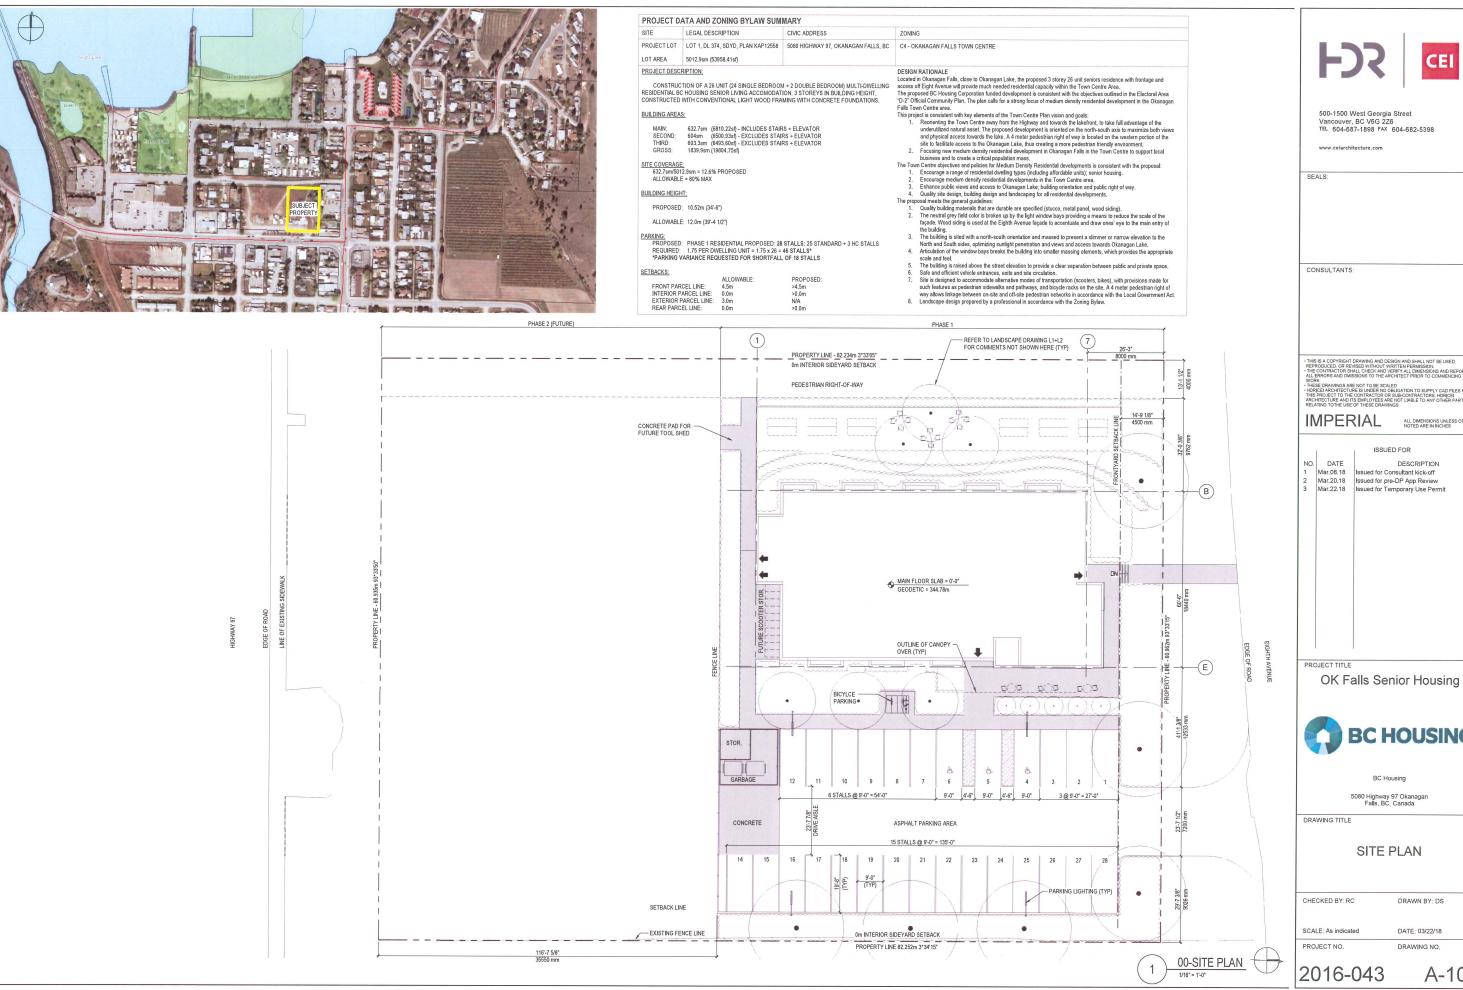


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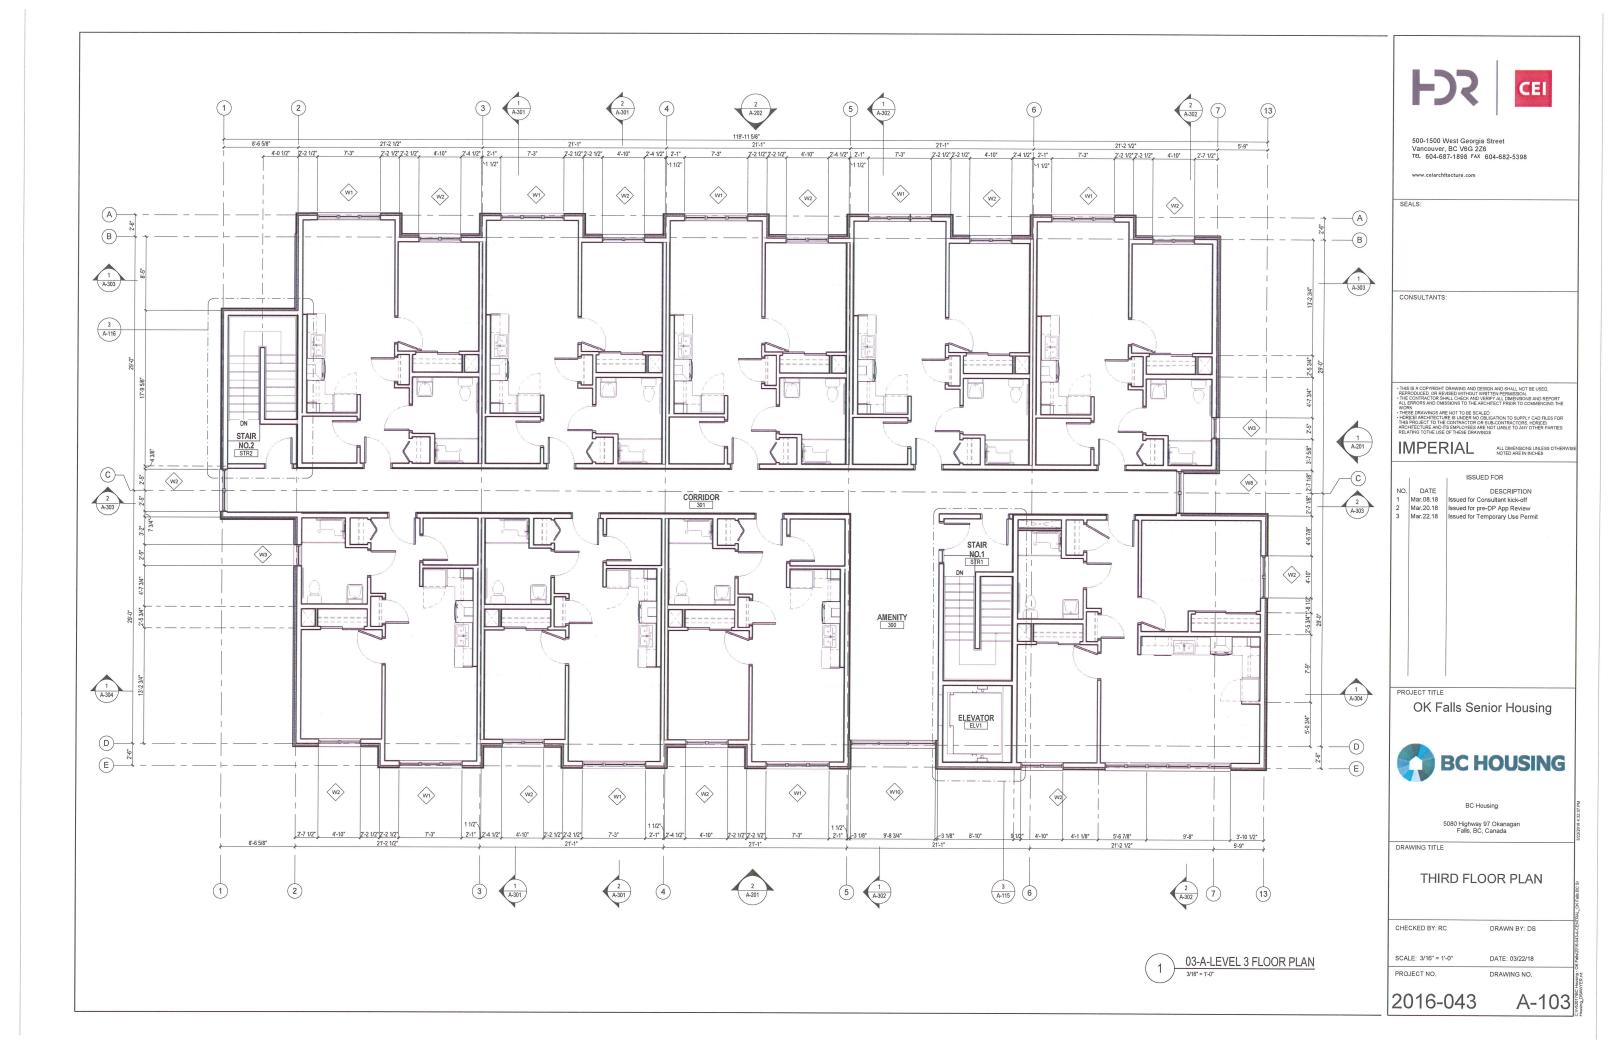





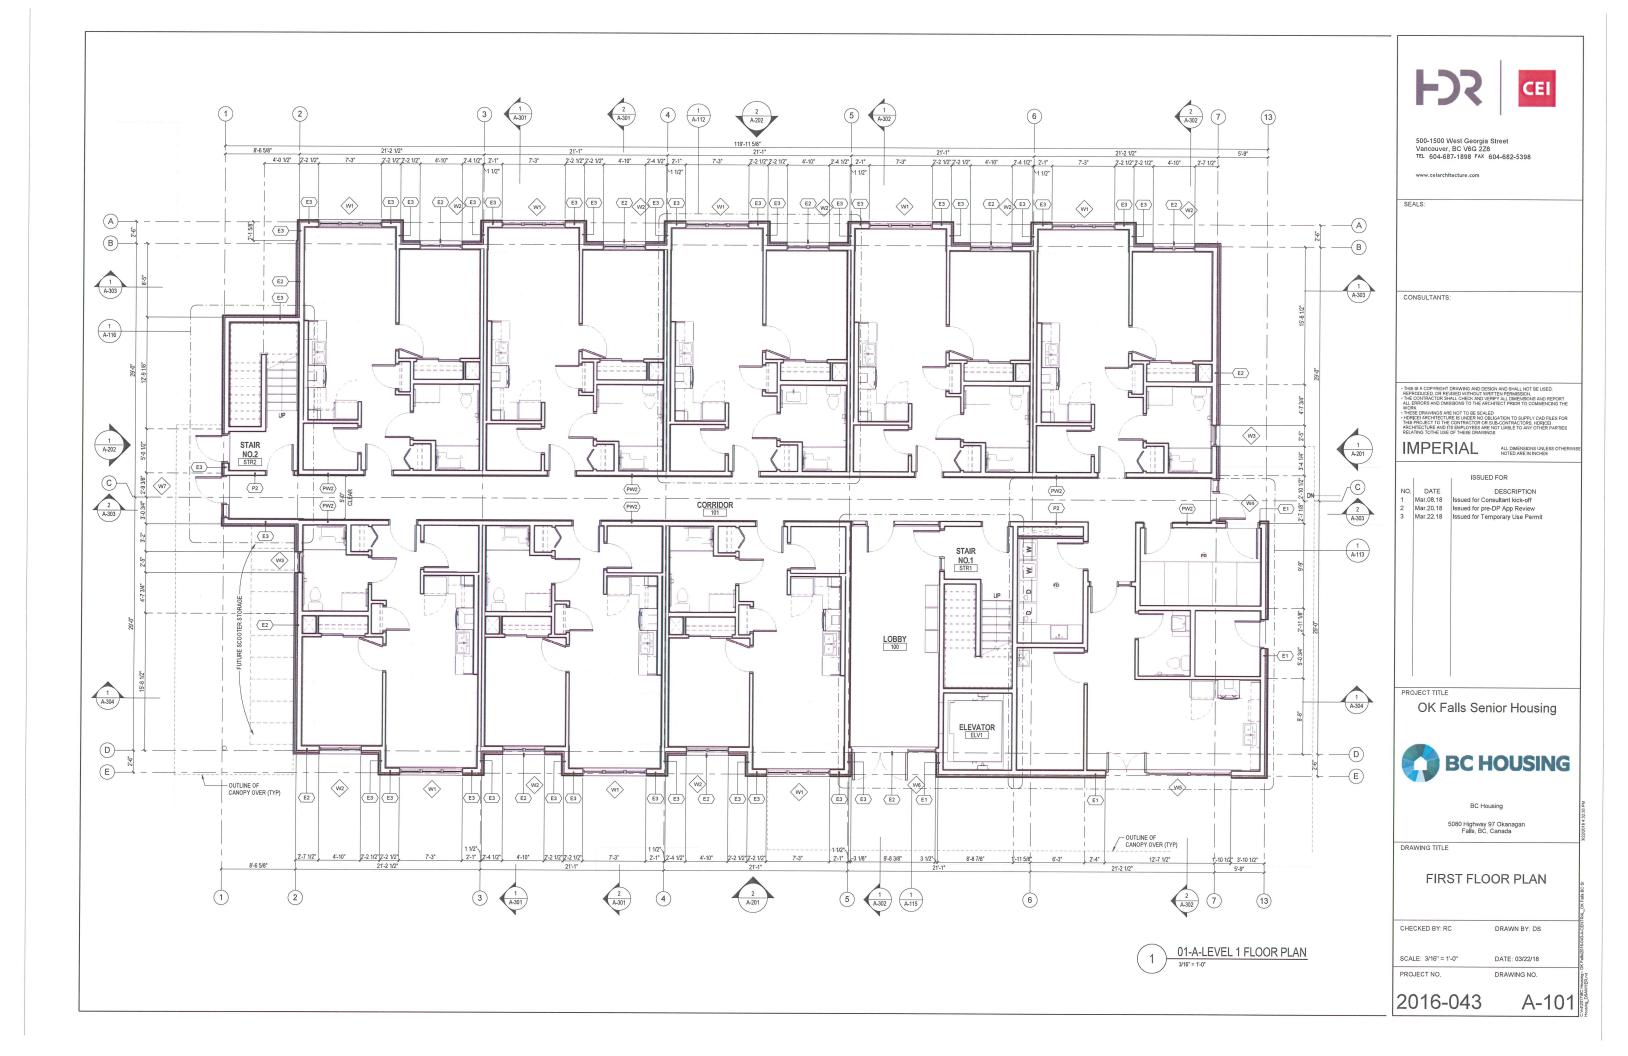

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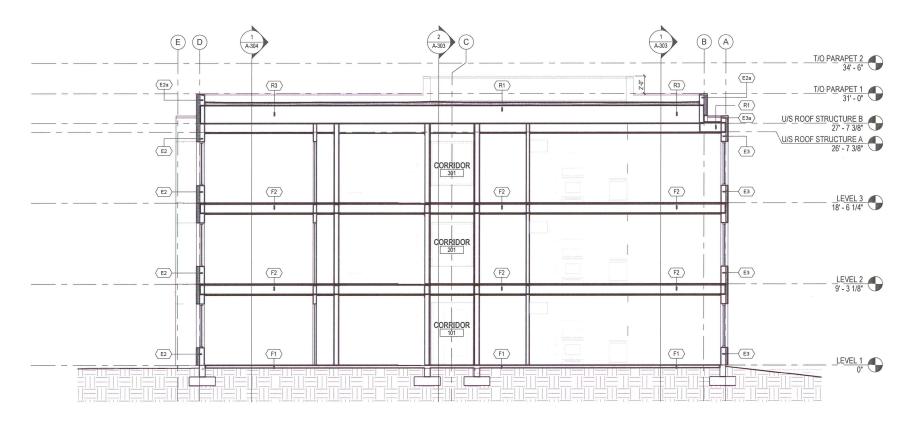


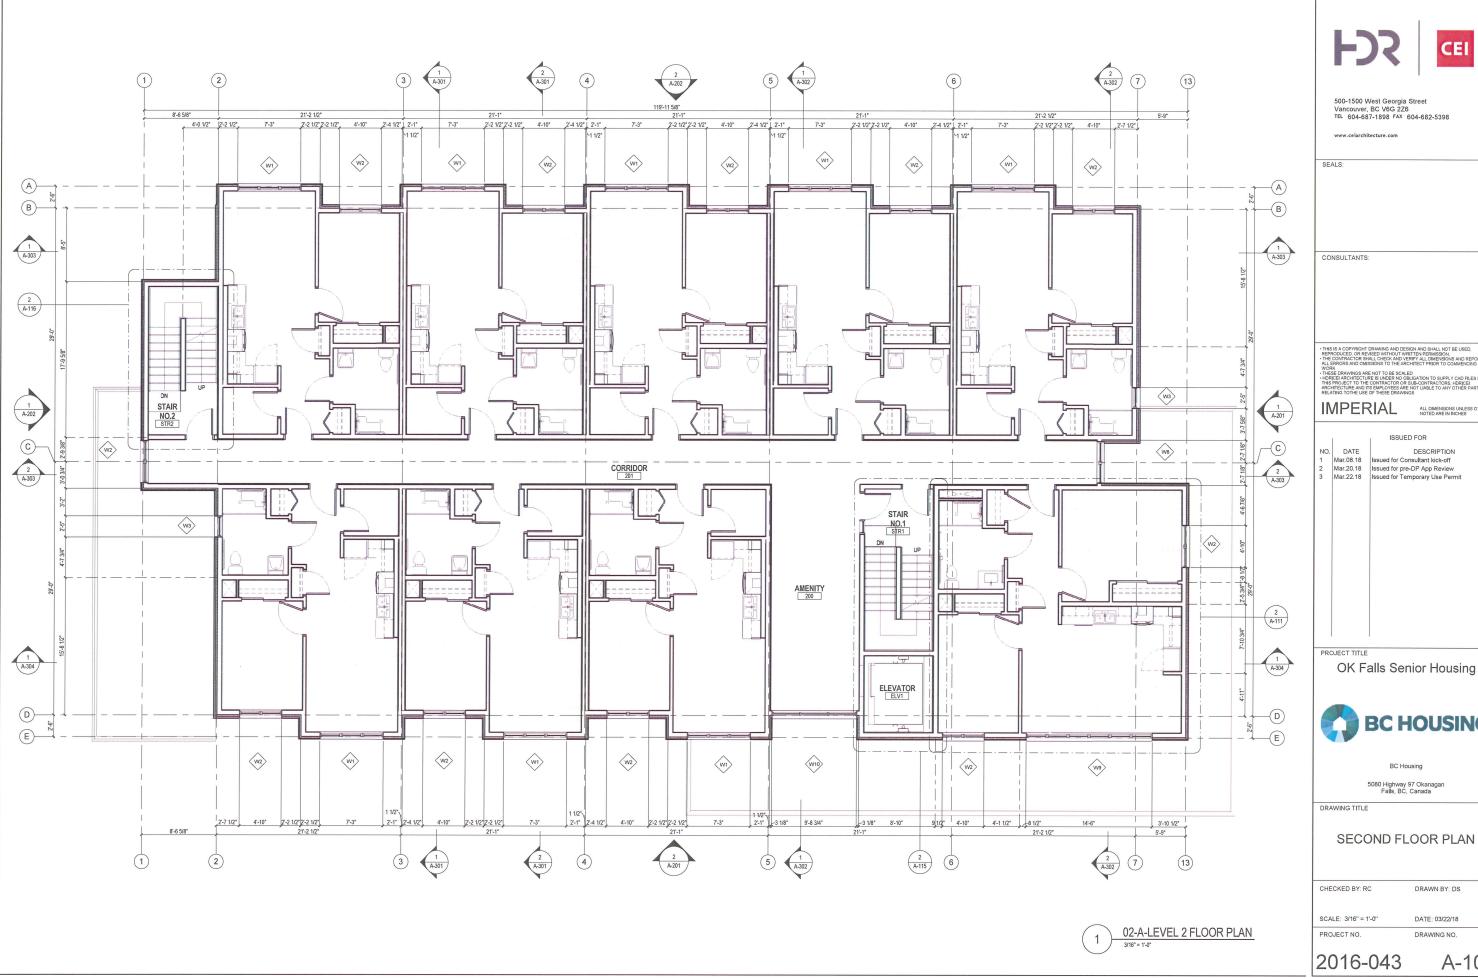




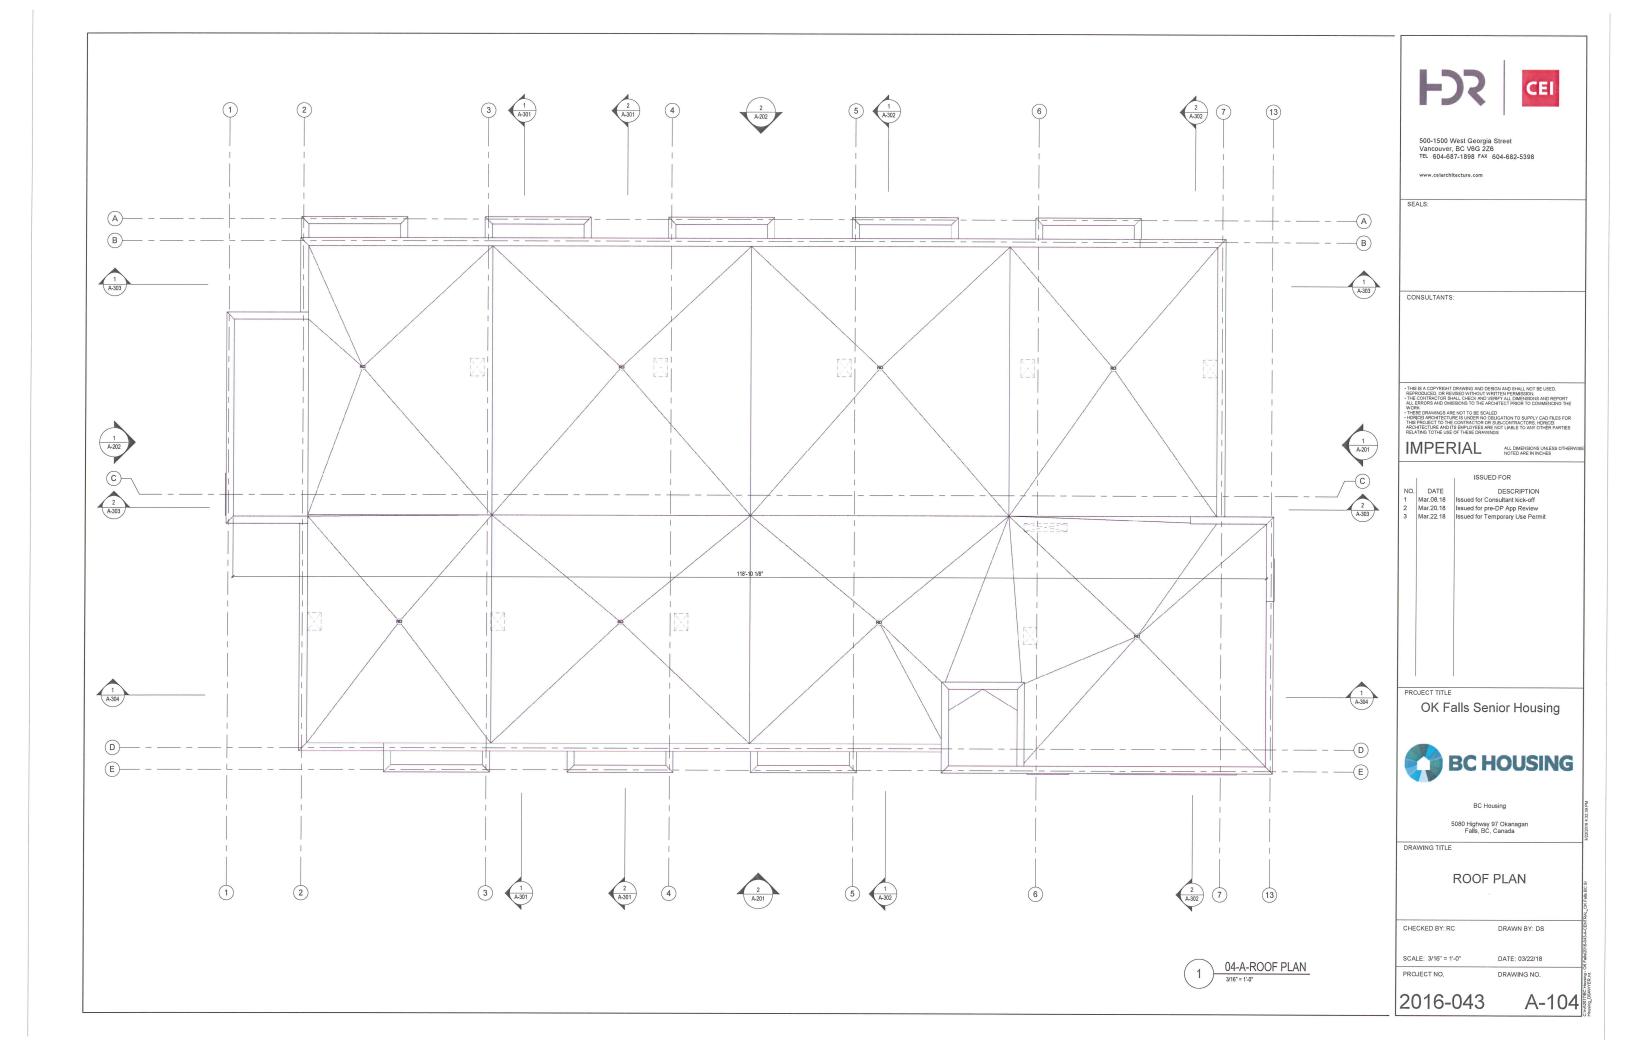





OVERALL BUILDING SECTION

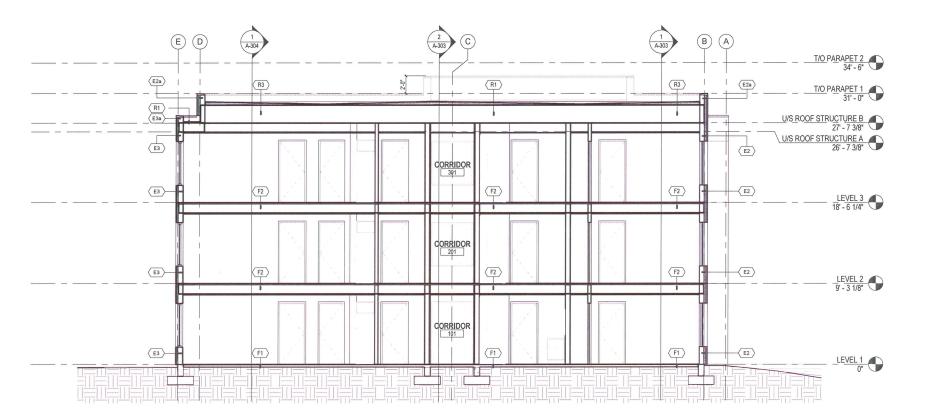

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PROJECT TITLE

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DRAWING TITLE

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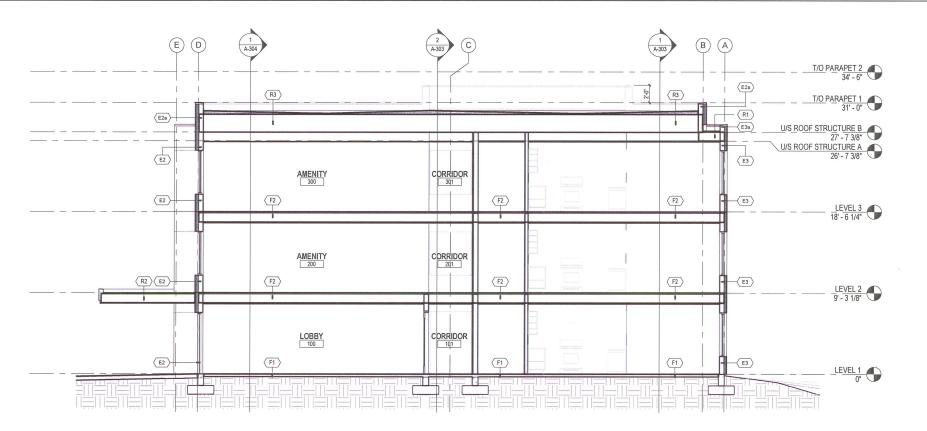
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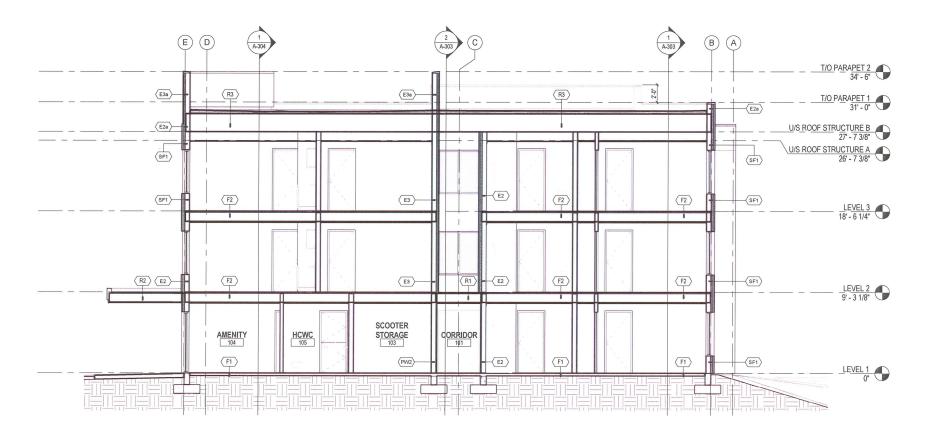
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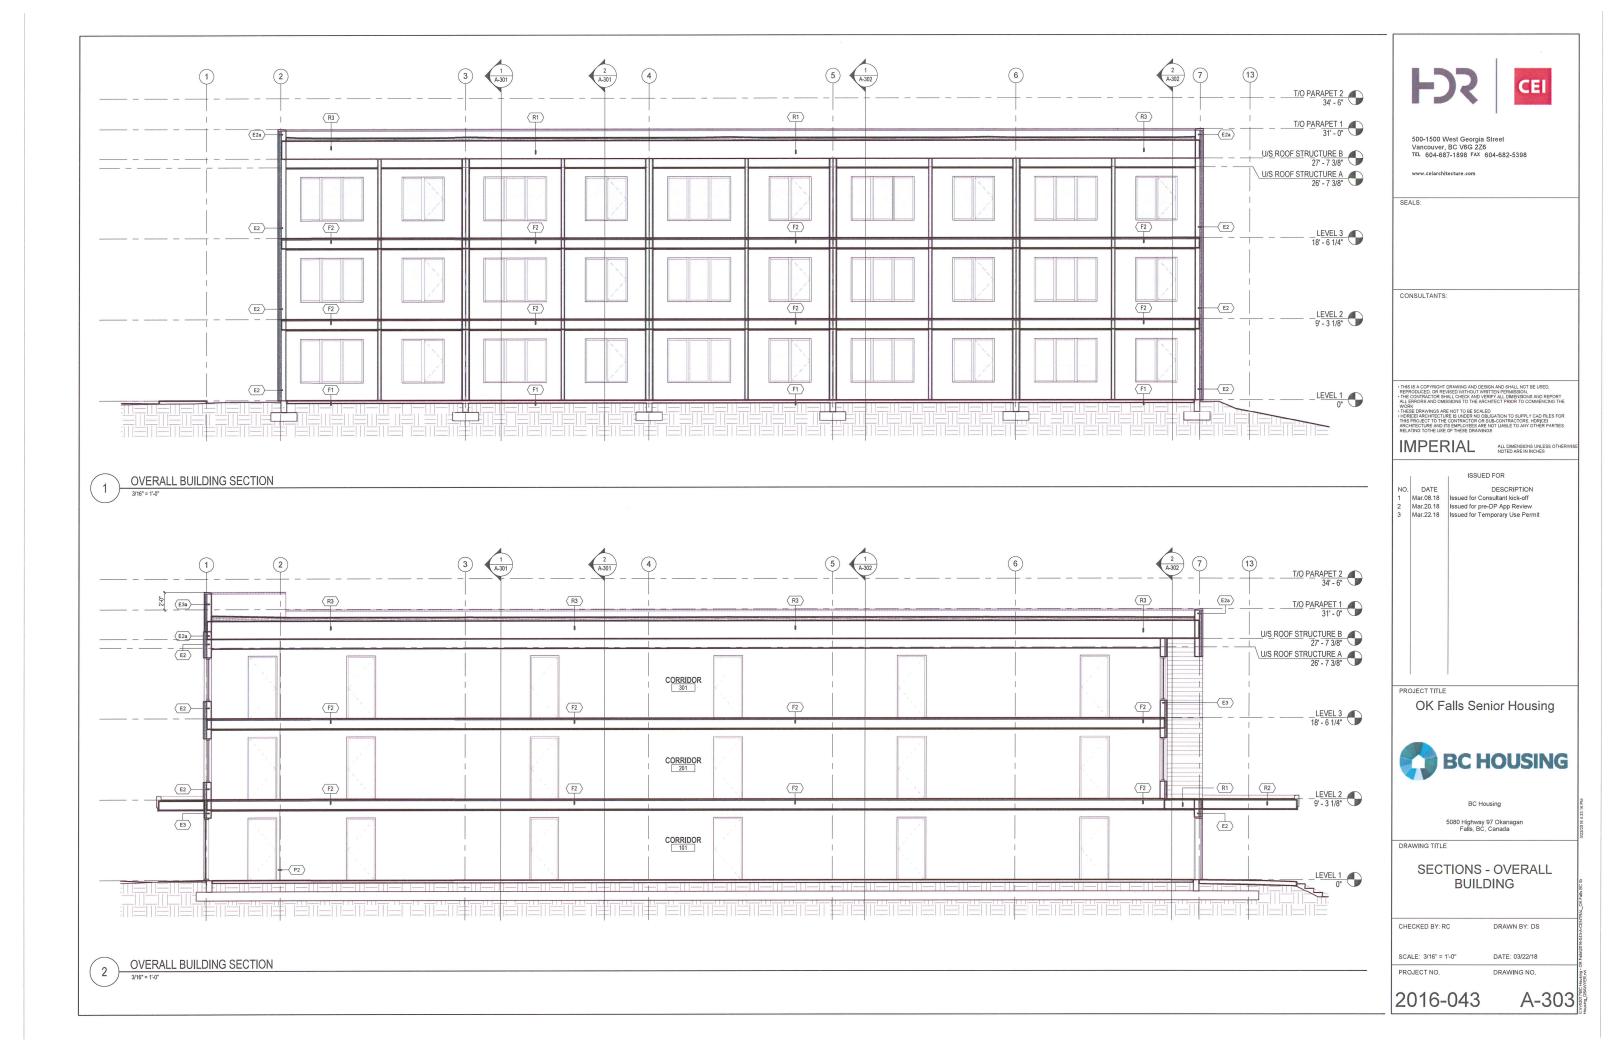
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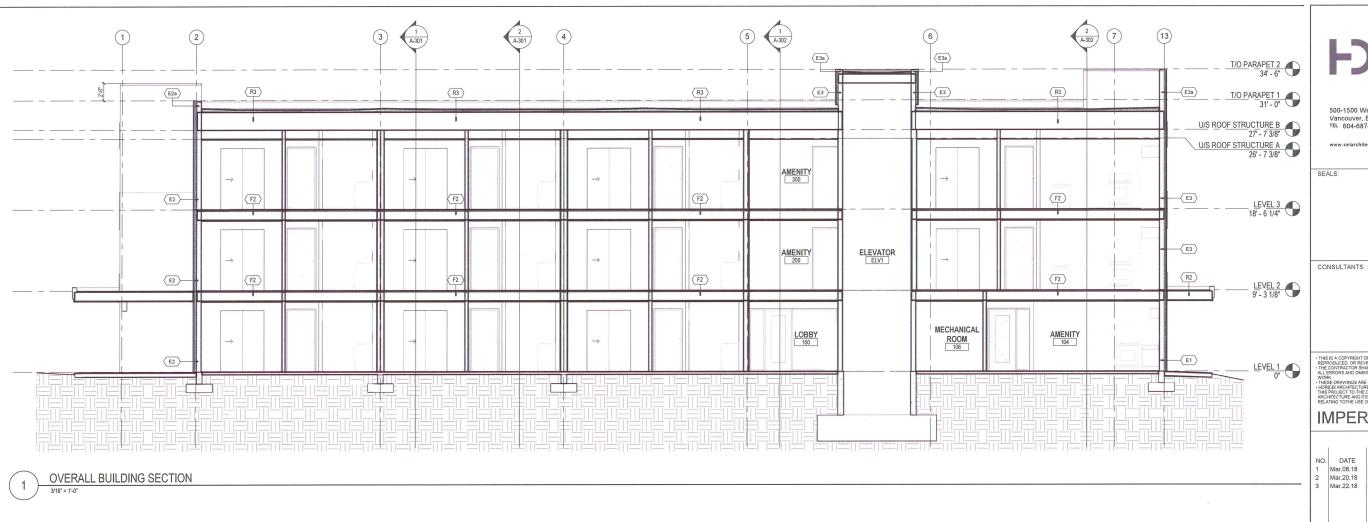
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